


VILLAGE 4


SAWGRASS BLVD. LEFT TURN LANE

Prepared For:
KMF ALTON
 105 NE 1ST STREET
 DELRAY BEACH, FL 33444
 (561) 682-9500

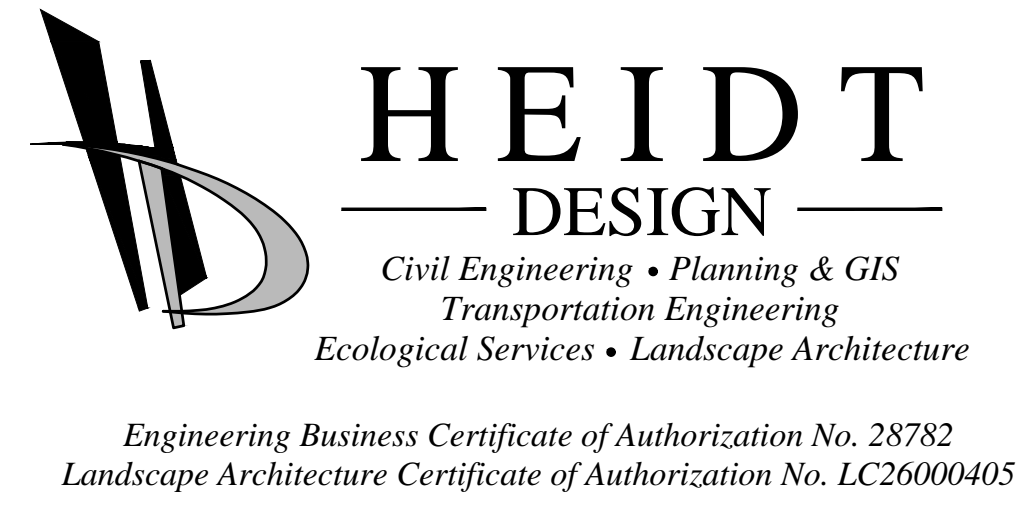

CONSTRUCTION PLAN

SECTIONS 13, 14 & 23 TOWNSHIP 24 SOUTH, RANGE 26 EAST
 LAKE COUNTY, FLORIDA

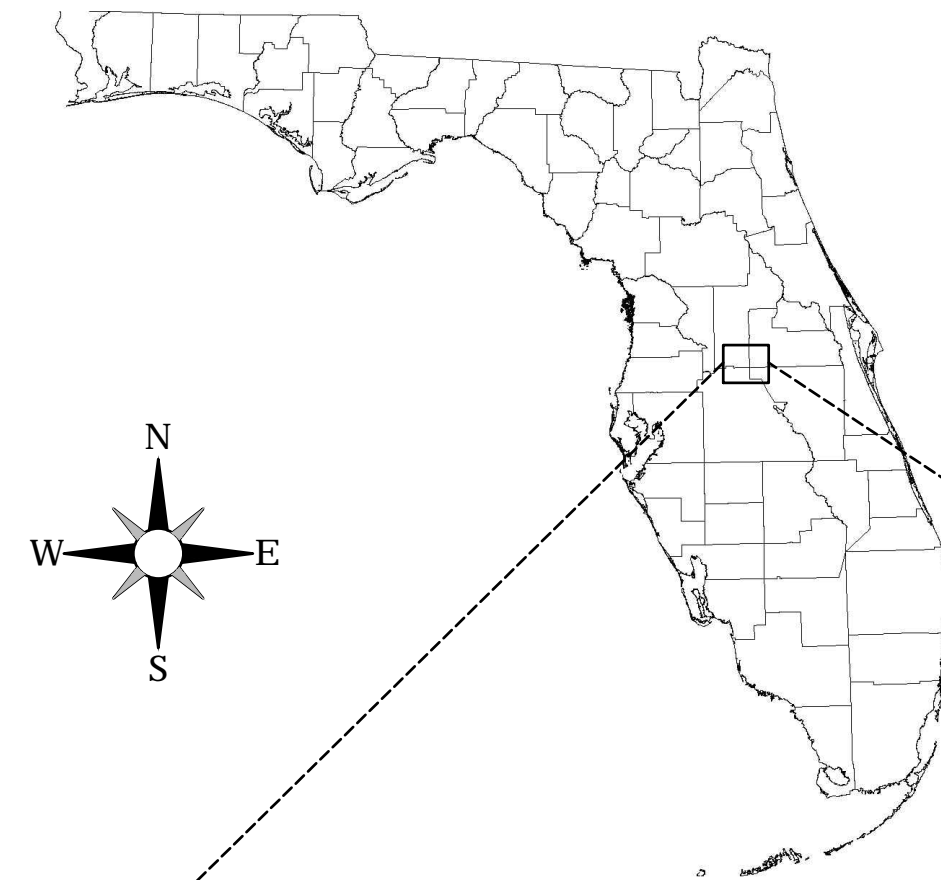

LOCATION MAP
 (NOT TO SCALE)



SITE MAP
 (NOT TO SCALE)

OWNER/DEVELOPER:

KMF ALTON
 105 NE 1ST STREET
 DELRAY BEACH, FL 33444
 (561) 682-9500
 ATTN: ROB TALA
 RTALA@KOLTER.COM

GEO TECHNICAL ENGINEER:

ECS FLORIDA, LLC
 JOHN P. HICKS, P.E.
 2815 DIRECTORS ROW, SUITE 500
 ORLANDO, FLORIDA 32809
 (407) 859-8378
 JHICKS@ECSLIMITED.COM

CIVIL ENGINEER:

HEIDT DESIGN, LLC
 MICHAEL R. TUCKER P.E.
 1130-A CELEBRATION BLVD.
 CELEBRATION, FLORIDA 34747
 (321) 559-8521
 MTUCKER@HEIDTDESIGN.COM

SURVEYOR:

GEOPOINT SURVEYING, INC.
 DAVID W. MAXWELL, P.L.S.
 213 HOBBS STREET
 TAMPA, FL 33619
 (813) 248-8888
 DMAXWELL@GEOPOINTSURVEY.COM

Sheet List Table	
Sheet Number	Sheet Title
C-100	COVER SHEET
C-101	GENERAL NOTES
C-102	GENERAL NOTES
C-103	EXISTING SITE CONDITIONS & DEMOLITION PLAN
C-200	TYPICAL SECTION
C-300	GRADING PLAN & ROAD SECTIONS
C-700	SIGNING & PAVEMENT MARKINGS PLAN

KMF ALTON
 SERENOA LLC

VILLAGE 4
 SAWGRASS BLVD. LEFT TURN LANE

DATE	DESCRIPTION
07/15/2022	C-103, C-300, C-700
05/27/2022	C-200, C-300, C-700
04/04/2022	REVIEW SUBMITTAL

DATE	DESCRIPTION

© COPYRIGHT 2022, HEIDT DESIGN, LLC. ALL RIGHTS RESERVED. NO DOCUMENTATION (INCLUDING BUT NOT LIMITED TO DRAWINGS OR EXHIBITS) MAY BE COPIED, REPRODUCED, OR DISTRIBUTED UNLESS SPECIFIC WRITTEN PERMISSION HAS BEEN OBTAINED FROM HEIDT DESIGN, LLC. IN ADVANCE. CONSENT IS HEREBY GRANTED SPECIFICALLY TO GOVERNMENTAL AGENCIES TO REPRODUCE THIS DOCUMENTATION IN COMPLIANCE WITH F.S. CHAPTER 119.



ELEVATIONS BASED ON: NORTH AMERICAN VERTICAL DATUM 1988 CONVERSION: NAVD 88 TO NGVD 29 = +0.86	
ADDRESS CONTROL NUMBER	
WATER COMMITMENT	
SEWER COMMITMENT	
SWFWMD	
WATER DEP	
SEWER DEP	
FOLIO	
PERMIT / FILE NUMBERS	

STATE OF FLORIDA PROFESSIONAL ENGINEER	FILE:	COVER
	PROJECT NO:	KMF-SN-1007
	GRADING & DRAINAGE	
	DESIGN BY:	J. VIDALES
	DRAWN BY:	J. VIDALES
	UTILITIES	
	DESIGN BY:	WS DESIGN
	DRAWN BY:	WS DRAWN
	COVER SHEET	
		C-100
	MICHAEL R. TUCKER	
	DATE:	40569
	LICENSE NO.	40569

Michael R. Tucker, State of Florida, Professional Engineer,
 License No. 40569
 This item has been digitally signed and sealed by
 Michael R. Tucker, P.E. on the date indicated here.
 Printed copies of this document are not considered signed and
 sealed and the signature must be verified on any electronic copies.

GENERAL PROJECT DATA

FOR IDENTIFICATION OF CONTRACTUAL AGREEMENTS, THIS SET OF DRAWINGS IS DATED 04/04/2022. ANY REVISIONS THEREAFTER WILL BE NOTED AND DATED ON THE AFFECTED DRAWING(S).

EXISTING UTILITY LOCATION

THE LOCATIONS OF ALL EXISTING UTILITIES SHOWN ON THE PLANS HAVE BEEN DETERMINED FROM THE BEST INFORMATION AVAILABLE AND ARE GIVEN FOR THE CONVENIENCE OF THE CONTRACTOR. THE ENGINEER ASSUMES NO RESPONSIBILITY FOR THEIR ACCURACY. PRIOR TO THE START OF ANY CONSTRUCTION ACTIVITY, IT SHALL BE THE CONTRACTOR'S RESPONSIBILITY TO NOTIFY THE VARIOUS UTILITIES AND TO MAKE THE NECESSARY ARRANGEMENTS FOR ANY RELOCATIONS TO THESE UTILITIES WITH THE OWNER OF THE UTILITY. THE CONTRACTOR SHALL EXERCISE CAUTION WHEN CROSSING AN UNDERGROUND UTILITY, WHETHER SHOWN ON THE PLANS OR LOCATED BY THE UTILITY COMPANY. ALL UTILITIES THAT INTERFERE WITH THE PROPOSED CONSTRUCTION SHALL BE RELOCATED. ANY COST, DELAY OR INCONVENIENCE CAUSED TO THE CONTRACTOR BY THE RELOCATION OF VARIOUS UTILITIES SHALL BE INCIDENTAL TO THE CONTRACT, AND NO EXTRA COMPENSATION WILL BE ALLOWED.

A SINGLE POINT UTILITY LOCATION SERVICE HAS BEEN SET UP FOR PARTICIPATING UTILITIES. THE CONTRACTOR IS TO CONTACT THE SUNSHINE STATE ONE CALL CENTER AT LEAST TWO (2) AND NO MORE THAN FIVE (5) WORKING DAYS PRIOR TO THE SPECIFIC CONSTRUCTION ACTIVITY FOR FIELD LOCATION. NOTE THAT NOT ALL UTILITIES PARTICIPATE IN THIS PROGRAM. THE CONTRACTOR SHOULD CONTACT NON-PARTICIPATING UTILITIES SEPARATELY FOR THEIR FIELD LOCATION OF FACILITIES. PER FLORIDA STATUTE 553.851, THE CONTRACTOR OR EXCAVATOR IS REQUIRED TO NOTIFY THE GAS COMPANY TWO (2) WORKING DAYS PRIOR TO STARTING EXCAVATION.

SOILS/ENVIRONMENTAL/PERMITS

SOILS INVESTIGATIONS FOR THE SITE WERE PROVIDED BY ECS FLORIDA, LLC. THE CONTRACTOR IS TO OBTAIN A COPY OF THAT SOILS REPORT FOR REVIEW PRIOR TO CONSTRUCTION. AND THE CONSTRUCTION IS TO CONFORM TO THE RECOMMENDATIONS IN THAT REPORT.

ENVIRONMENTAL/CONSERVATION INVESTIGATIONS: BIO-TECH CONSULTING INC. SURVEY INFORMATION PREPARED BY: GEOPPOINT SURVEYING PERMITS AVAILABLE TO CONTRACTOR: _____

AS-BUILTS

AS-BUILTS SHALL BE PROVIDED BY THE CONTRACTOR TO THE ENGINEER TWO WEEKS PRIOR TO FINAL INSPECTION. ALL AS-BUILT DATA SHALL BE PROVIDED BY A FLORIDA LICENSED SURVEYOR, SIGNED, SEALED, AND DATED BY THE RESPONSIBLE PARTY. SEE INDIVIDUAL SECTIONS (SEWER, WATER SYSTEM, ETC.) FOR ADDITIONAL AS-BUILT REQUIREMENTS. UTILITIES, INC. OF FLORIDA REQUIRES ASSET TABLES - NORTHING & EASTING USING STATE PLANE COORDINATES FOR ALL VALVES, FITTINGS, SERVICES, LATERALS, MHS, & PIPE INTERVALS AT 100' PERMITS AND PERMIT REQUIREMENTS

THE CONTRACTOR SHALL OBTAIN FROM THE OWNER COPIES OF ALL REGULATORY AND LOCAL AGENCY PERMITS. THE CONTRACTOR SHALL BE EXPECTED TO REVIEW AND ABIDE BY ALL THE REQUIREMENTS AND LIMITATIONS SET FORTH IN THE PERMITS.

THE CONTRACTOR SHALL BE FURNISHED A COPY OF THE N.P.D.E.S. NOTICE OF INTENT APPLICATION AND REPORT WHICH WAS FURNISHED TO EPA BY THE OWNER. THE CONTRACTOR SHALL REVIEW THE CONTENTS OF THAT SUBMITTAL INCLUDING CONSTRUCTION COMMENCEMENT AND CESSATION DATES AND ALL OTHER ELEMENTS OF THE SUBMITTAL. HE SHALL EXECUTE AND FILE AN N.O.I. TO EPA AS THE ENTITY RESPONSIBLE FOR OPERATING AND MAINTAINING THE EROSION PROTECTION SYSTEM DURING CONSTRUCTION, NOTING ANY CHANGES AND/OR MODIFICATIONS AND/OR AGREEING TO THE ELEMENTS OF THE ORIGINAL SUBMITTAL. HE SHALL SUBMIT THIS AT LEAST 48 HOURS PRIOR TO COMMENCING CONSTRUCTION. THE CONTRACTOR SHALL KEEP ON-SITE A COPY OF THE WATER MANAGEMENT DISTRICT AND N.P.D.E.S. PERMITS ISSUED TOGETHER WITH THE INSPECTION REPORTS AND CURRENT PLANS, INCLUDING ANY MODIFICATIONS REQUIRED. HE SHALL ALSO PROVIDE A NOTICE OF TERMINATION TO THE N.P.D.E.S. PERMITTING AUTHORITY AT THE CONCLUSION OF THE PROJECT THAT THE DISCHARGE AND EROSION PROTECTION DEVICE AS SHOWN ON THE PLANS HAVE BEEN IMPLEMENTED AND MAINTAINED THROUGHOUT CONSTRUCTION.

LAYOUT AND CONTROL

UNLESS OTHERWISE NOTED ON THE PLANS, THE CONTRACTOR SHALL USE THE GEOMETRY PROVIDED ON THE SURVEY PLAT. BENCHMARK INFORMATION SHALL BE PROVIDED TO THE CONTRACTOR BY THE OWNER OR OWNER'S SURVEYOR. ANY DISCREPANCIES BETWEEN FIELD MEASUREMENTS AND CONSTRUCTION PLAN INFORMATION SHALL BE BROUGHT TO THE ATTENTION OF THE ENGINEER IMMEDIATELY. THE SURVEYOR WHO PRODUCED THE PLAT IS GEOPPOINT SURVEYING, (321) 270-0440.

QUALITY CONTROL TESTING REQUIREMENTS

ALL TESTING RESULTS SHALL BE PROVIDED TO THE OWNER/OPERATOR, COUNTY, AND THE ENGINEER. TESTING REQUIREMENTS ARE TO BE IN ACCORDANCE WITH THE OWNER/OPERATOR'S SPECIFICATIONS AND REQUIREMENTS. ALL TEST RESULTS SHALL BE PROVIDED (PASSING AND FAILING) ON A REGULAR AND IMMEDIATE BASIS. CONTRACTOR SHALL PROVIDE TESTING SERVICES THROUGH A FLORIDA LICENSED GEOTECHNICAL ENGINEERING FIRM ACCEPTABLE TO THE OWNER AND ENGINEER. NO TESTING TO BE SCHEDULED ON MONDAY OR FRIDAY.

SHOP DRAWINGS

SHOP DRAWINGS AND CERTIFICATIONS FOR ALL STORM DRAINAGE, WATER SYSTEM, AND PAVING SYSTEM MATERIALS AND STRUCTURES ARE REQUIRED. THE CONTRACTOR SHALL SUBMIT SHOP DRAWINGS TO THE ENGINEER AND UTILITY FOR APPROVAL PRIOR TO ORDERING THE MATERIALS REQUIRED FOR CONSTRUCTION.

EARTHWORK

EARTHWORK QUANTITIES

THE CONTRACTOR SHALL PERFORM HIS OWN INVESTIGATIONS AND CALCULATIONS AS NECESSARY TO ASSURE HIMSELF OF EARTHWORK QUANTITIES. THERE IS NO IMPLICATION THAT EARTHWORK BALANCES AND THE CONTRACTOR SHALL BE RESPONSIBLE FOR ANY IMPORT FILL NEEDED, OR FOR REMOVAL AND DISPOSAL OF EXCESS MATERIALS.

EROSION CONTROL

EROSION AND SILTATION CONTROL MEASURES ARE TO BE PROVIDED AND INSTALLED PRIOR TO COMMENCEMENT OF CONSTRUCTION. THESE MEASURES ARE TO BE INSPECTED BY THE CONTRACTOR ON A REGULAR BASIS AND ARE TO BE MAINTAINED OR REPAIRED ON AN IMMEDIATE BASIS, AS REQUIRED. REFER TO ST. JOHNS RIVER WATER MANAGEMENT DISTRICT PERMIT FOR ADDITIONAL REQUIREMENTS FOR EROSION CONTROL AND SURFACE DRAINAGE.

WETLAND PROTECTION

THE LIMITS OF THE ON-SITE WETLANDS HAVE BEEN PROVIDED TO THE CONTRACTOR ON THE CONSTRUCTION PLANS OR ON PERMIT MATERIALS. THE WETLANDS AREAS ARE TO BE PROTECTED FROM DISTURBANCE AT ALL TIMES. CONTRACTOR SHALL PROVIDE EROSION, SILTATION, AND DIVERSION MEASURES PRIOR TO COMMENCEMENT OF CONSTRUCTION. THE CONTRACTOR SHALL OBTAIN A COPY OF EACH PERMIT RELATING TO WETLANDS AND ADHERE TO ALL PROVISIONS AND CONDITIONS THERETO.

LIMITS OF DISTURBANCE

AT NO TIME SHALL THE CONTRACTOR DISTURB SURROUNDING PROPERTIES OR TRAVEL ON SURROUNDING PROPERTIES WITHOUT WRITTEN CONSENT FROM THE PROPERTY OWNER. REPAIR OR RECONSTRUCTION OF DAMAGED AREAS ON SURROUNDING PROPERTIES SHALL BE PERFORMED BY THE CONTRACTOR ON AN IMMEDIATE BASIS. ALL COSTS FOR REPAIRS SHALL BE THE RESPONSIBILITY OF THE CONTRACTOR AND NO EXTRA COMPENSATION SHALL BE PROVIDED.

TREE REMOVAL

THE CONTRACTOR SHALL NOTIFY THE OWNER AND ENGINEER WHEN ALL WORK IS LAID OUT (SURVEY STAKED), SO THAT A DETERMINATION MAY BE MADE OF SPECIFIC TREES TO BE REMOVED. NO TREES SHOWN ON THE CONSTRUCTION PLANS AS BEING SAVED SHALL BE REMOVED WITHOUT PERMISSION FROM THE OWNER AND ENGINEER.

CLEARING AND GRUBBING

THE CONTRACTOR SHALL BE RESPONSIBLE FOR CLEARING AND GRUBBING FOR SITE CONSTRUCTION INCLUDING CLEARING FOR PAVING, UTILITIES, DRAINAGE FACILITIES AND BUILDING CONSTRUCTION. SEE PLANS FOR LIMITS OF CLEARING AND GRUBBING. ALL AREAS TO BE CLEARED SHALL BE FIELD STAKED AND REVIEWED BY THE OWNER AND ENGINEER PRIOR TO ANY CONSTRUCTION.

MATERIAL STORAGE / DEBRIS REMOVAL

ALL MATERIALS EXCAVATED SHALL REMAIN THE PROPERTY OF THE OWNER AND SHALL BE STOCKPILED AT ON-SITE LOCATIONS AS SPECIFIED BY THE OWNER. MATERIALS SHALL BE STOCKPILED SEPARATELY AS TO USABLE (NON ORGANIC) FILL STOCKPILES AND ORGANIC (MUCK) STOCKPILES IF MUCK IS ENCOUNTERED. CONTRACTOR SHALL BE RESPONSIBLE FOR THE REMOVAL OF ALL UNSUITABLE FILL MATERIALS FROM THE SITE. ALL CLAY ENCOUNTERED SHALL BE EXCAVATED OUT AND REPLACED WITH CLEAN GRANULAR FILL MATERIALS.

FILL MATERIAL

ALL FILL MATERIALS SHALL NOT CONTAIN MUCK, STUMPS, ROOTS, BRUSH, VEGETATIVE MATTER, RUBBISH OR OTHER MATERIAL THAT WILL NOT COMPACT INTO A SUITABLE AND ENDURING BACKFILL. FILL SHALL BE CLEAN, NON-ORGANIC, GRANULAR MATERIAL WITH NOT MORE THAN 10% PASSING THE NO. 200 SIEVE.

COMPACTION

FILL MATERIALS PLACED UNDER ROADWAYS SHALL BE COMPACTED TO AT LEAST 98% OF THE MAXIMUM DENSITY AS SPECIFIED IN AASHTO T-180. ALL OTHER FILL AREAS ARE TO BE COMPACTED TO AT LEAST 95% MAXIMUM DENSITY AS SPECIFIED IN AASHTO T-180. FILL MATERIALS SHALL BE PLACED AND COMPACTED IN A MAXIMUM OF 12" LIFTS. THE CONTRACTOR SHALL PROVIDE THE ENGINEER AND OWNER WITH ALL (PASSING AND FAILING) TESTING RESULTS. RESULTS SHALL BE PROVIDED ON A TIMELY AND REGULAR BASIS PRIOR TO CONTRACTOR'S PAY REQUEST SUBMITTAL FOR THE AFFECTED WORK.



1130-A Celebration Blvd
Celebration, Florida 34747
Office: 321-559-8521
Fax: 813-464-7629
www.HeidtDesign.com



VILLAGE 4
SAWGRASS BLVD. LEFT TURN LANE
GENERAL NOTES
PREPARED FOR:
KMF ALTON

DATE	DESCRIPTION

DATE	DESCRIPTION
04/04/2022	REVIEW SUBMITTAL

PROJECT NO: KMF-SN-1007
FILE: GNOTES-SAWGRASS
DESIGN BY: J. VIDALES
DRAWN BY: J. VIDALES

STATE OF FLORIDA
PROFESSIONAL ENGINEER
Michael R. Tucker, State of Florida,
Professional Engineer, License
No. 40569
This item has been digitally
signed and sealed by
Michael R. Tucker, P.E. on the
date indicated here.
Printed copies of this document
are not considered signed and
sealed and the signature must be
verified on any electronic copies.



MICHAEL R. TUCKER
DATE: _____
LICENSE NO. 40569

C-102

ELEVATIONS BASED ON:
NORTH AMERICAN VERTICAL DATUM 1988
CONVERSION:
NAVD 88 TO NGVD 29 = +0.86

R:\VALON GROVES\SAWGRASS BLVD VILLAGE 4 ENTRANCE\ENGINEERING\NOTES\SAWGRASS DWG-C-102 2022\0715 11:57 AM BRETT DAVIS

© COPYRIGHT 2022 HEIDT DESIGN, LLC. ALL RIGHTS RESERVED. NO DOCUMENTATION INCLUDING BUT NOT LIMITED TO DRAWINGS OR EXHIBITS MAY BE REPRODUCED OR TRANSMITTED IN ANY FORM OR BY ANY MEANS, ELECTRONIC OR MECHANICAL, INCLUDING PHOTOCOPYING, RECORDING, OR BY ANY INFORMATION STORAGE AND RETRIEVAL SYSTEM, WITHOUT PERMISSION IN WRITING FROM HEIDT DESIGN, LLC. PERMISSION IS HEREBY GRANTED SPECIFICALLY TO GOVERNMENTAL AGENCIES TO REPRODUCE THIS DOCUMENT IN COMPLIANCE WITH F.S. CHAPTER 119.

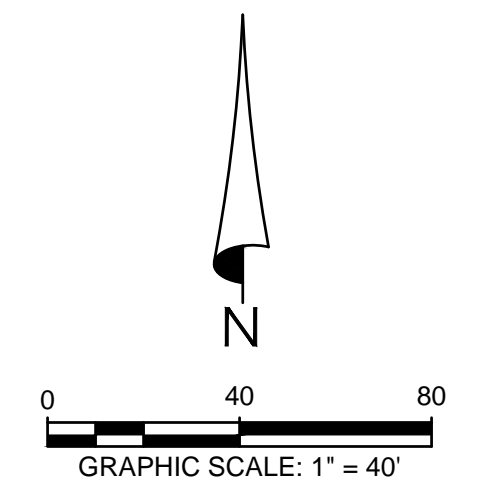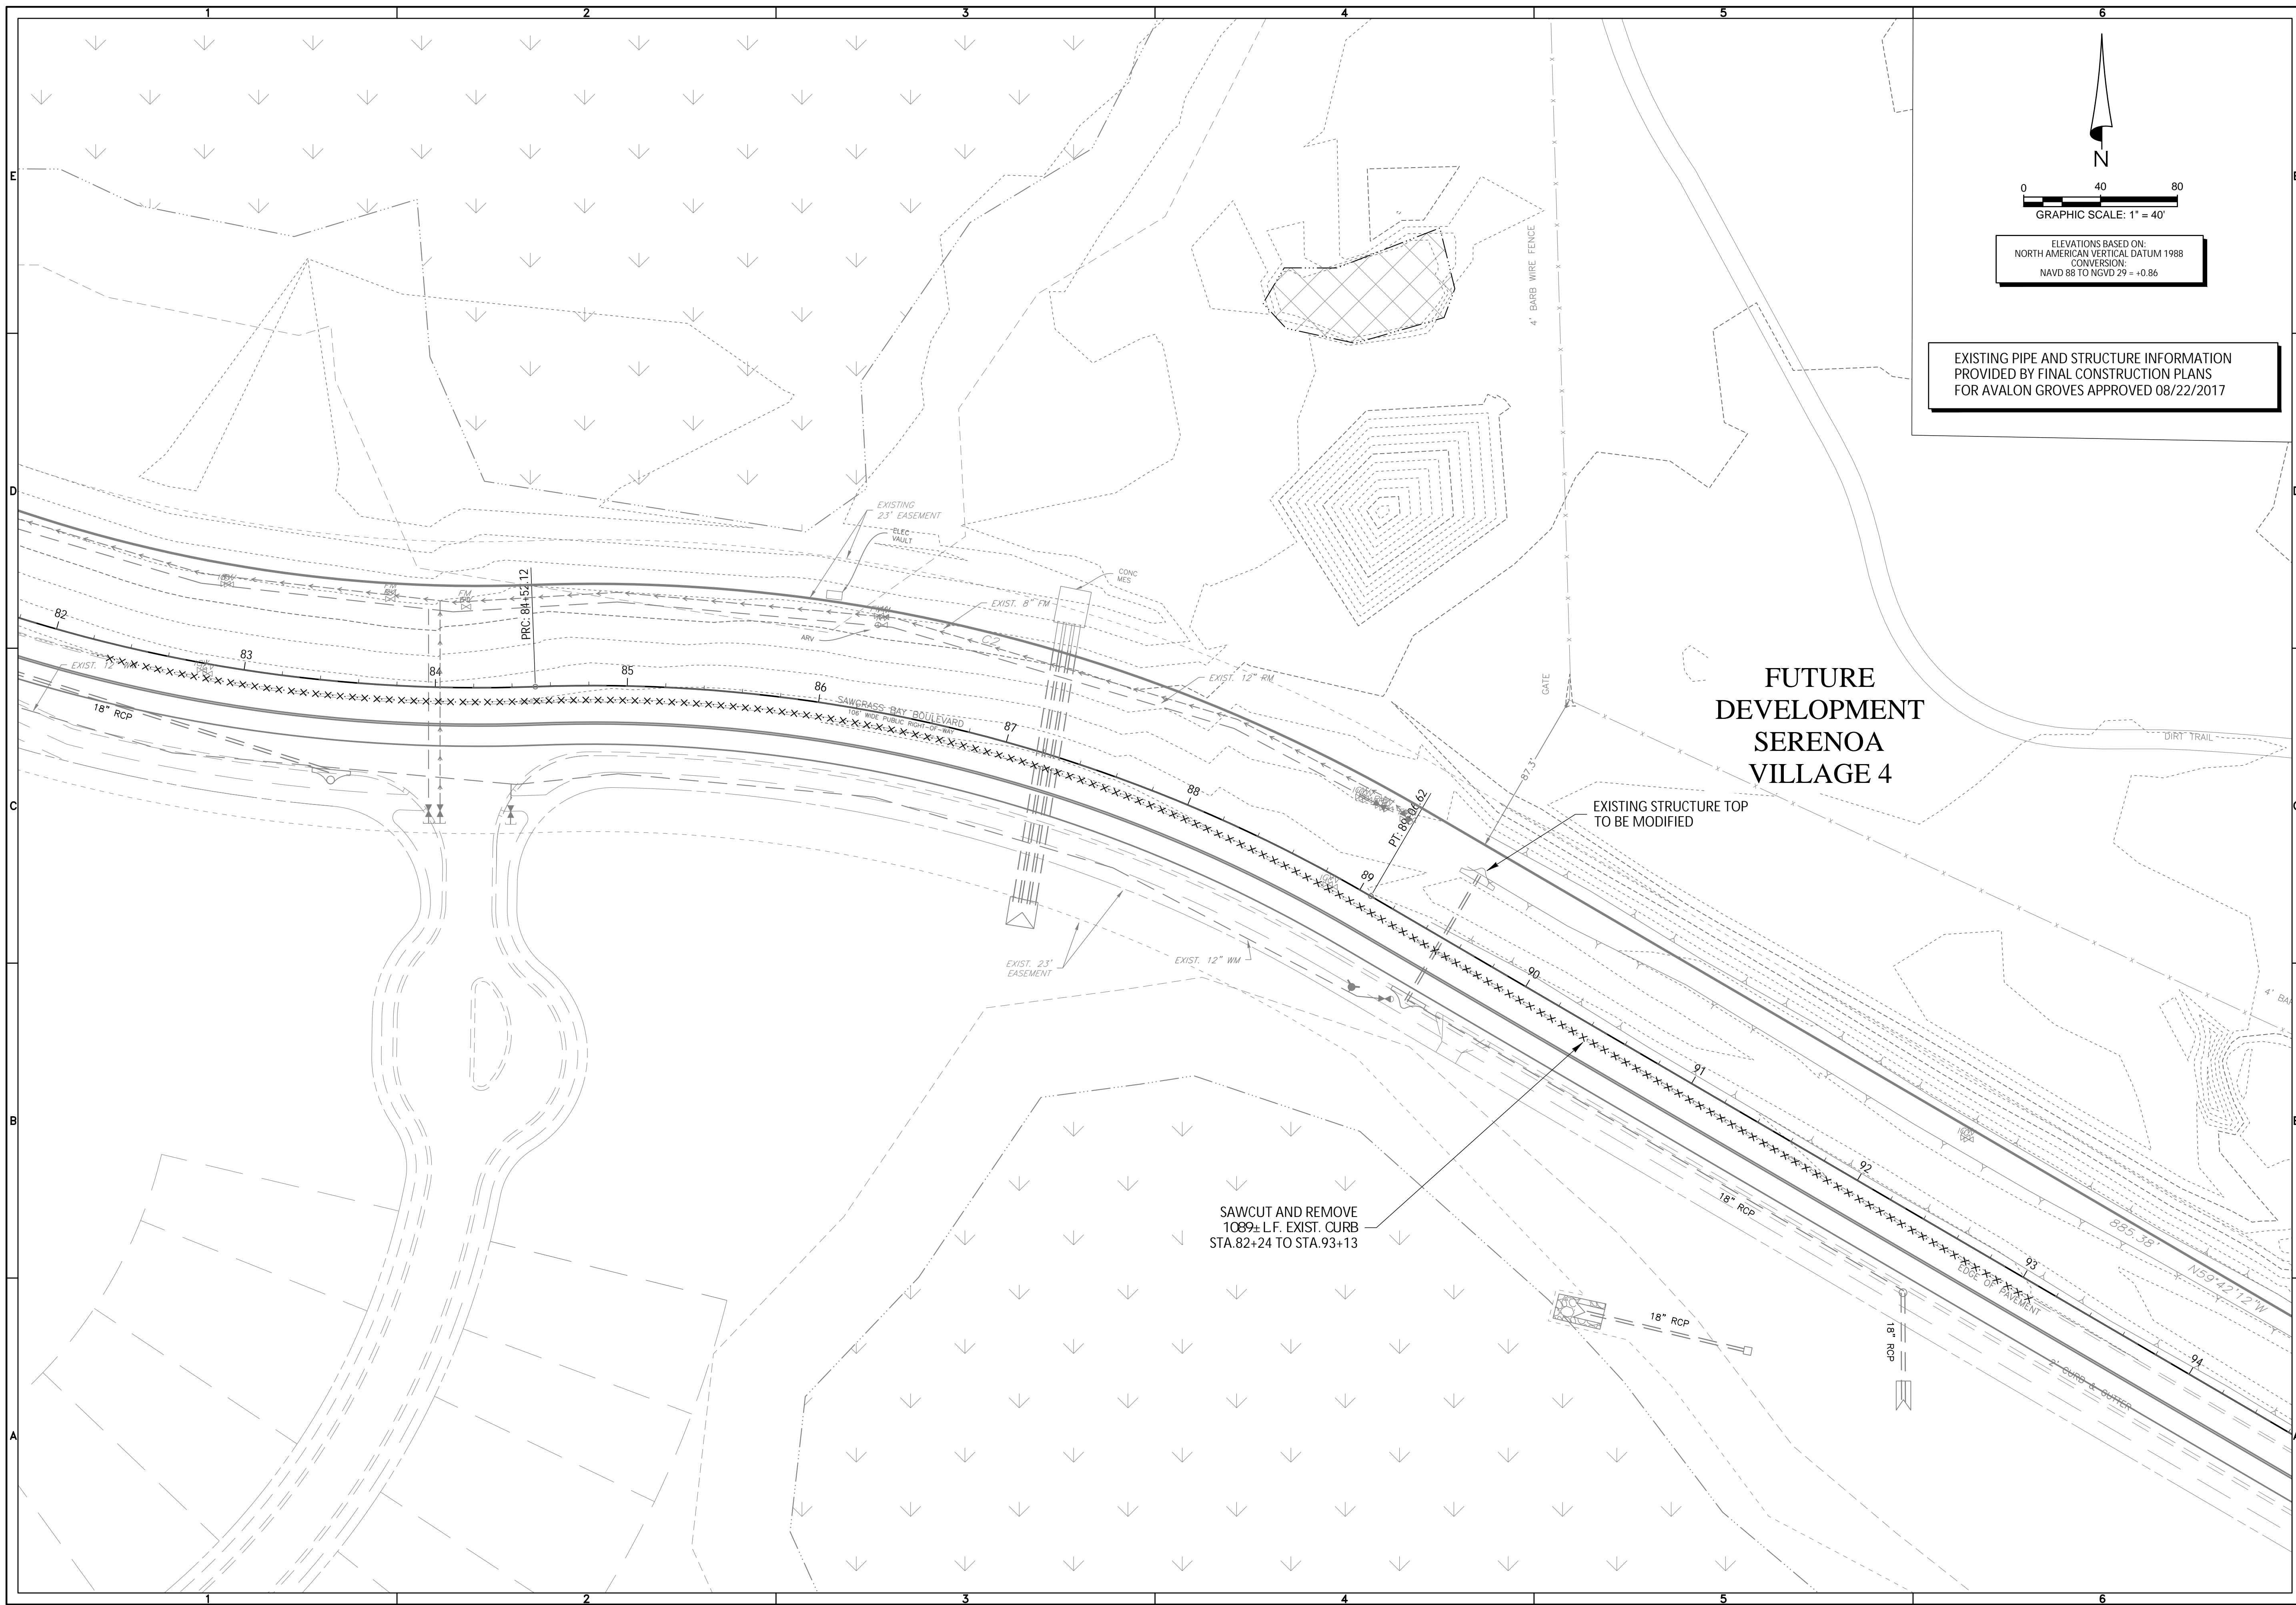


EXISTING PIPE AND STRUCTURE INFORMATION PROVIDED BY FINAL CONSTRUCTION PLANS FOR AVALON GROVES APPROVED 08/22/2017

FUTURE DEVELOPMENT SERENOA VILLAGE 4

SAWCUT AND REMOVE 1089± L.F. EXIST. CURB STA.82+24 TO STA.93+13

EXISTING STRUCTURE TOP TO BE MODIFIED

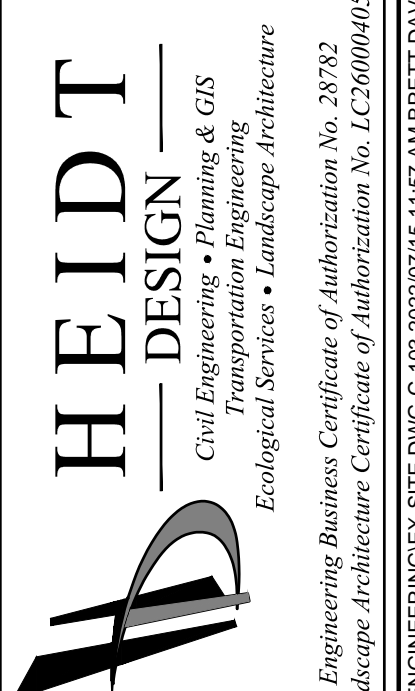

HEIDT DESIGN
Civil Engineering • Planning & GIS
Transportation Engineering
Ecological Services • Landscape Architecture
Engineering Business Certificate of Authorization No. 28793
Landscape Architecture Certificate of Authorization No. LC26080405

5904-A Hampton Oaks Pkwy.
Tampa, Florida 33610
Office: 813-253-5311
Fax: 813-464-7629
www.HeidtDesign.com

VILLAGE 4 SAWGRASS BLVD. LEFT TURN LANE EXISTING SITE CONDITIONS & DEMOLITION PLAN

PREPARED FOR: **KMF ALTON**

NO.	DATE	DESCRIPTION
2	07/15/2022	REVISED PER COUNTY COMMENTS
1	05/27/2022	REVISED PER COUNTY COMMENTS
1	06/04/2022	REVISED SUBMITTAL


PROJECT NO.: **KMF-SN-1007**
FILE: **EX-SITT**
DESIGN BY: **J. VIDALES**
DRAWN BY: **J. VIDALES**

STATE OF FLORIDA PROFESSIONAL ENGINEER
Michael R. Tucker, State of Florida Professional Engineer, License No. 40569
This item has been digitally signed and sealed by Michael R. Tucker, P.E., on the date indicated here.
Printed copies of this document are not considered signed and sealed and the signature must be verified on any electronic copies.

MICHAEL R. TUCKER
DATE: _____
LICENSE NO. **40569**

C-103

R:\AVALON GROVES\SAWGRASS BLVD VILLAGE 4 ENTRANCE\ENGINEERING\A SITE DWG-C-103 2022\0715 11:57 AM BRETT DAVIS

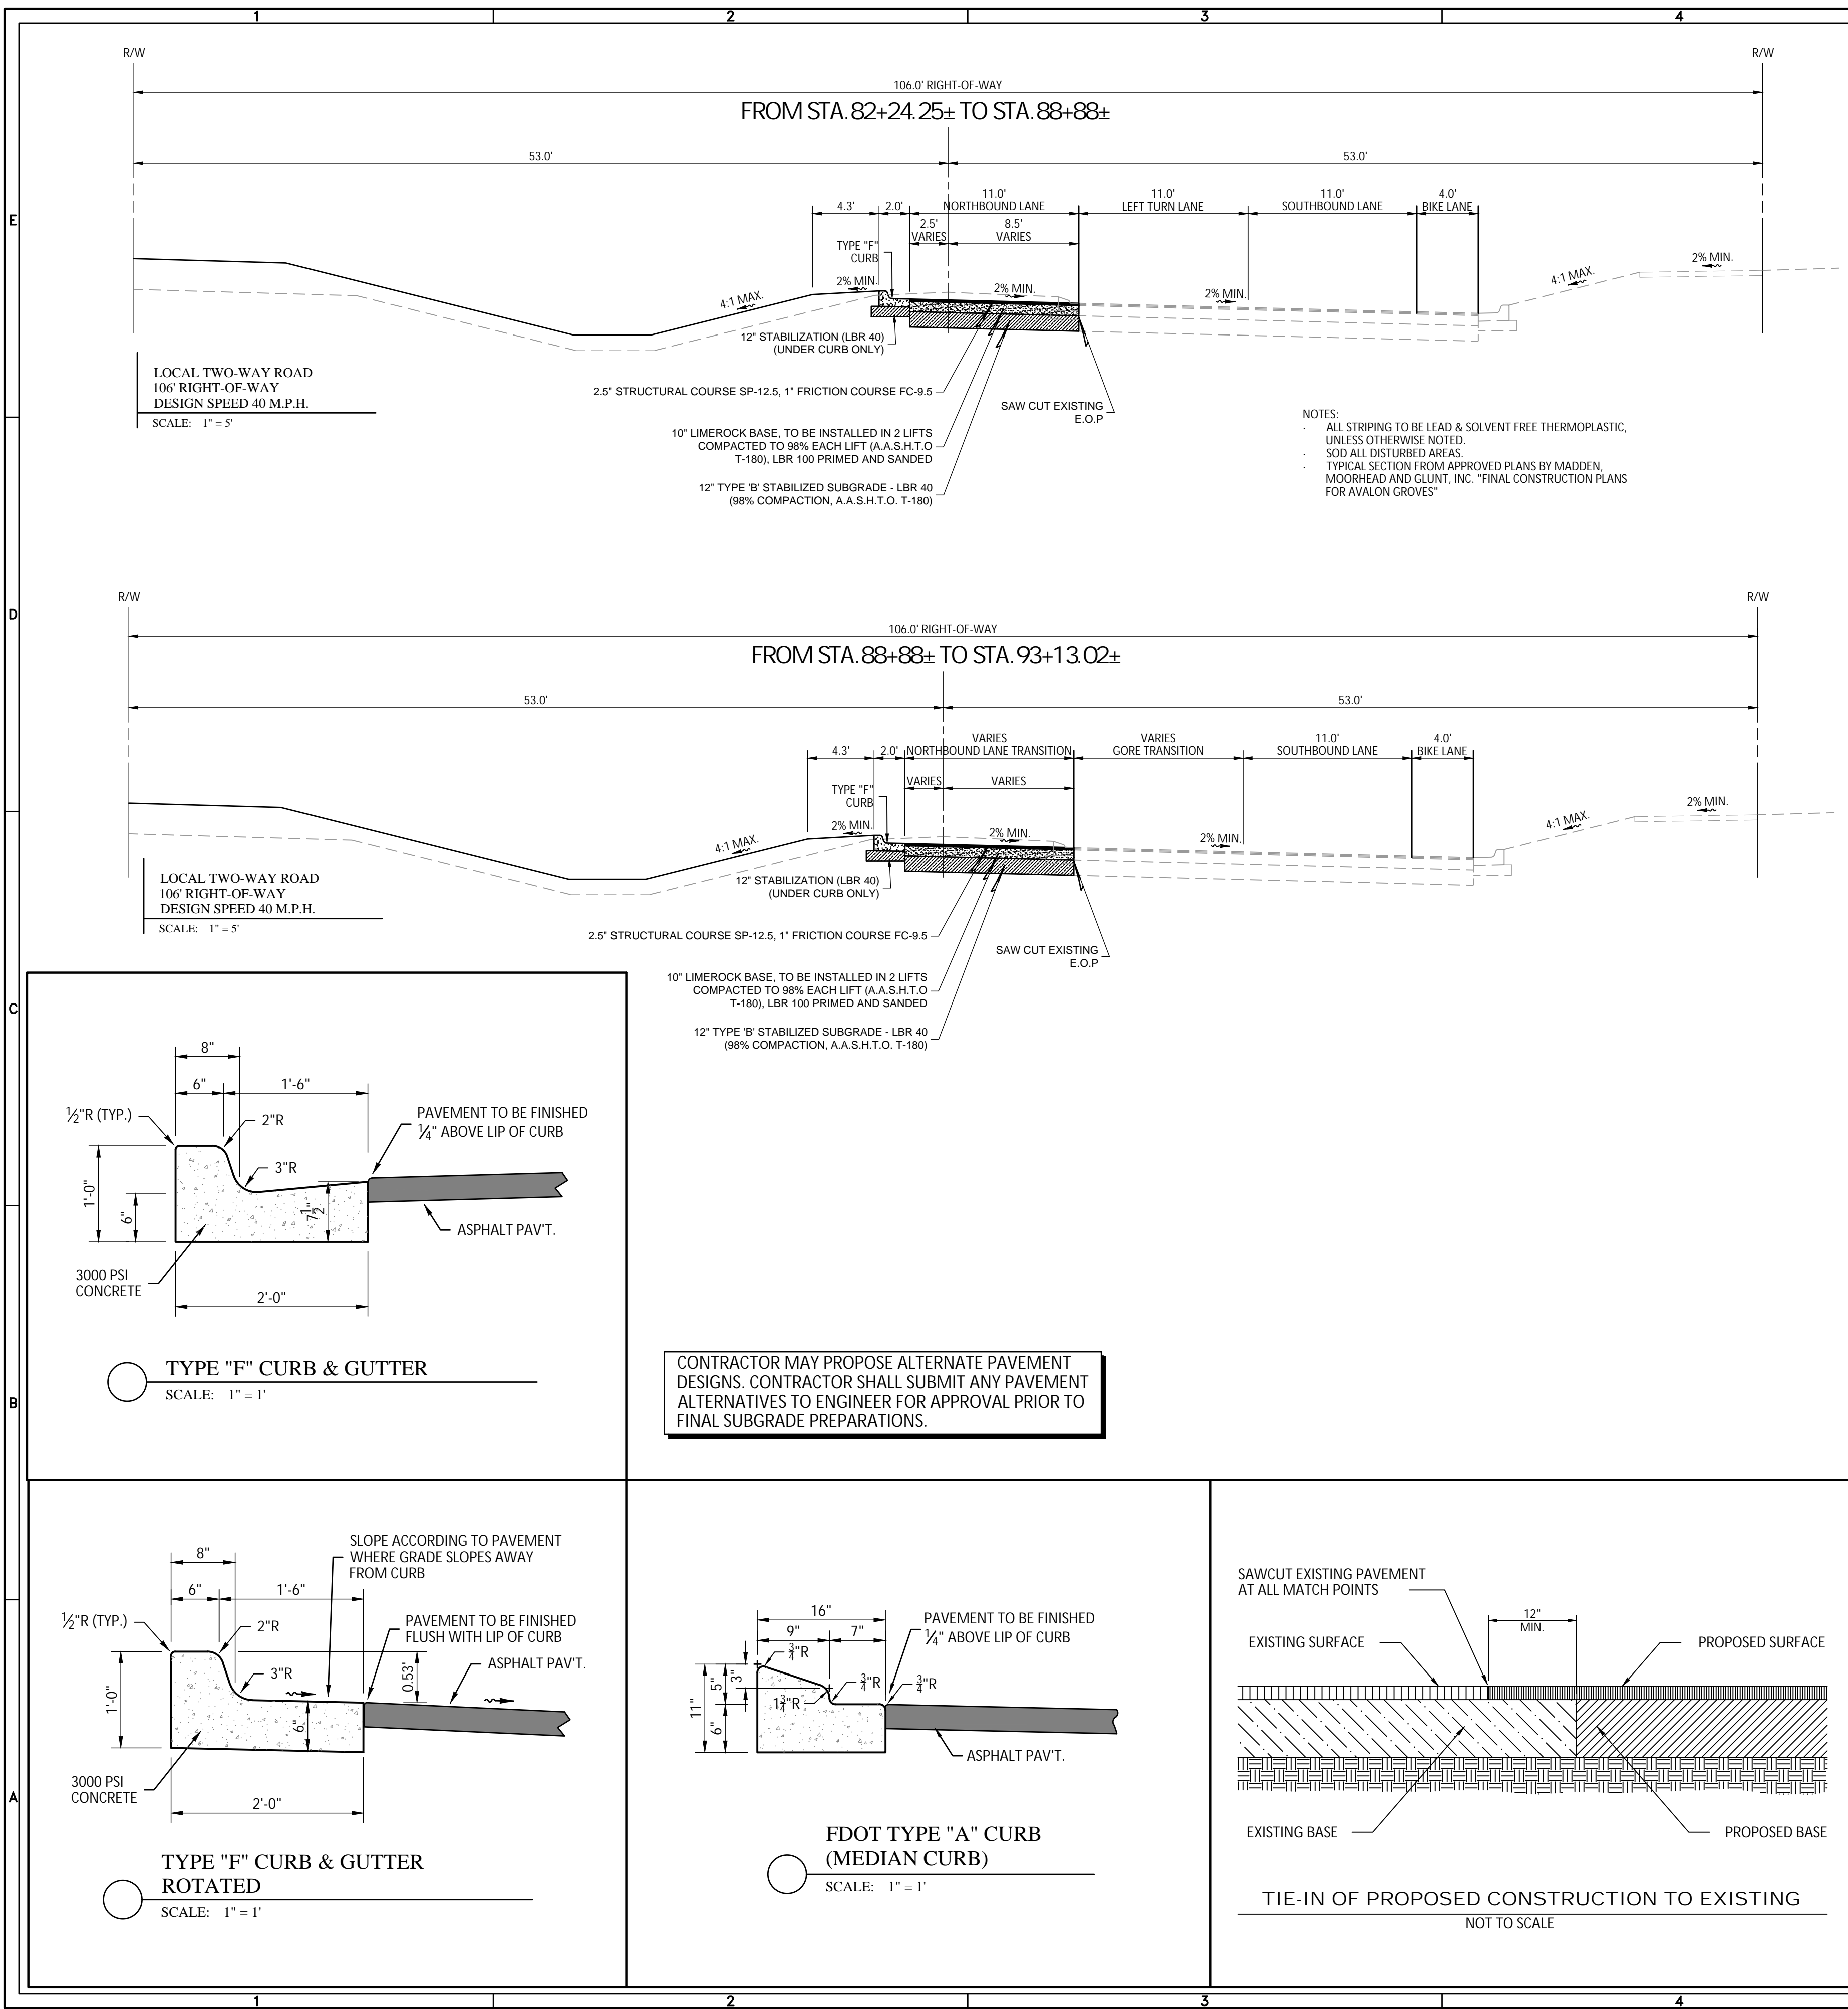

PAVEMENT CONSTRUCTION NOTES:

- SUBGRADE**
THE FOLLOWING ARE MINIMUM STANDARDS FOR THE STABILIZED SUBGRADE:
WIDTH - THE SUBGRADE SHALL BE TWO (2) FEET WIDER THAN THE BASE COURSE (ONE (1) FOOT EACH SIDE) AND IN THE CASE OF CURB AND GUTTER SHALL EXTEND SIX (6) INCHES BEHIND THE CURB.
DEPTH - THE SUBGRADE SHALL HAVE A MINIMUM DEPTH OF 12-INCHES.
COMPACTION - THE SUBGRADE SHALL BE COMPACTED TO 98% DENSITY HAVING A MINIMUM LBR 40.
CARE OF SUBGRADE - TRUCKS WILL BE ALLOWED ON FINISHED SUBGRADE TO DUMP BASE COURSE, BUT CONTRACTOR WILL BE REQUIRED TO LEVEL OUT RUTS. IN THE EVENT THE TRUCKS CAUSE TOO MUCH DAMAGE TO THE SUBGRADE, THE COUNTY MANAGER OR DESIGNEE MAY REQUIRE DUMPING, SPREADING, AND HAULING ON THE BASE COURSE.
- SHOULDERS**
THE FOLLOWING ARE MINIMUM STANDARDS FOR SHOULDERS:
WIDTH - SHOULDERS SHALL BE EIGHT FEET WIDE. A REDUCTION IN THE WIDTH REQUIREMENT MAY BE ALLOWED IF APPROVED BY THE COUNTY MANAGER OR DESIGNEE.
DEPTH - SHOULDERS SHALL HAVE A MINIMUM DEPTH OF SIX INCHES.
COMPACTION - SHOULDERS SHALL BE COMPACTED TO 95% COMPACTION LBR 40.
GRADING - SHOULDERS SHALL BE GRADED WITH A MINIMUM CROSS-SLOPE OF 1/4 INCH/FOOT.
- BASE COURSE**
THE FOLLOWING ARE MINIMUM STANDARDS FOR THE BASE COURSE:
MATERIAL - SOIL CEMENT IS ACCEPTABLE MATERIAL TYPES FOR THE ROAD BASE. OTHER MATERIALS MAY BE USED IF APPROVED BY THE COUNTY MANAGER OR DESIGNEE.
WIDTH - ALL BASES SHALL BE ONE (1) FOOT WIDER (SIX (6) INCHES EACH SIDE) THAN THE FINISHED SURFACE.
DEPTH - THE BASE SHALL HAVE A MINIMUM DEPTH OF SIX INCHES. HEAVY DUTY ROADS SHALL HAVE A BASE WITH A MINIMUM DEPTH OF EIGHT INCHES PLACED IN TWO LIFTS.
STRENGTH - SOIL CEMENT BASE SHALL HAVE A SEVEN DAY DESIGN COMPRESSIVE STRENGTH OF AT LEAST 300 PSI.
COMPACTION - LIMEROCK BASE (IF USED) SHALL BE COMPACTED TO A MINIMUM 98% DENSITY AS DETERMINED BY ASSHTO T-180. LBR 100
FORMS - NO FORM BOARDS WILL BE REQUIRED UNLESS, IN THE OPINION OF THE COUNTY MANAGER OR DESIGNEE, THE CONTRACTOR IS NOT TAKING PRECAUTIONS TO OBTAIN THE FULL DEPTH AT THE EDGES.
GRADING - THE BASE SHALL BE GRADED AND ROLLED TO CONFORM TO THE GRADE AND CROSS-SLOPE OF THE FINISHED ROADWAY.
PRIME COAT - PRIME COAT SHALL BE APPLIED TO ALL BASE COURSES, AND SAND SEALED.
NOTE: ROADWAYS DESIGNED WITH UNDERDRAINS SHALL UTILIZE BASE MATERIAL OF CRUSHED CONCRETE OR SOIL CEMENT AS NOTED IN THE GEOTECHNICAL REPORT.
- WEARING SURFACE**
THE FOLLOWING ARE MINIMUM STANDARDS FOR PAVEMENT WEARING SURFACE:
MATERIAL - SP 9.5 ASPHALTIC CONCRETE SHALL BE USED FOR THE ROAD WEARING SURFACE. OTHER ASPHALT TYPES MAY BE USED IF REQUIRED BY THE COUNTY MANAGER OR DESIGNEE.
DEPTH - ROADS SHALL HAVE A MINIMUM 1 1/2 - INCH DEPTH OF WEARING SURFACE. THE MINIMUM DEPTH MAY BE INCREASED IF REQUIRED BY THE COUNTY MANAGER OR DESIGNEE.
HEAVY DUTY ROADS - HEAVY DUTY SHALL HAVE A WEARING SURFACE CONSISTING OF MINIMUM OF TWO INCHES OF SP 12.5 ASPHALTIC CONCRETE OVERLAYED WITH A ONE INCH FRICTION COURSE. THE TYPE OF MATERIAL TO BE USED FOR THE FRICTION COURSE SHALL BE DETERMINED BY THE COUNTY MANAGER OR DESIGNEE.
GRADING - ROAD SURFACES SHALL BE GRADED WITH A MINIMUM CROSS-SLOPE OF 1/4 INCH/FOOT.
- CURB AND GUTTER**
THE WIDTH OF CURB AND GUTTER SHALL BE A MINIMUM OF TWENTY-FOUR (24) INCHES AND SHALL BE EITHER FLORIDA DEPARTMENT OF TRANSPORTATION TYPE F (STANDARD CURB AND GUTTER) OR MIAMI TYPE, DEPENDING UPON THE FLOW TO BE HANDLED. FDOT TYPE D (SIMPLE VERTICAL CURBING) WILL NOT BE ACCEPTABLE. FDOT TYPE A (MOUNTABLE MEDIAN CURB) MAY BE USED AROUND MEDIAN DIVIDERS ON THE HIGH SIDE OF PAVEMENT. THERE SHALL BE A STABILIZED SUBGRADE BENEATH ALL CURB AND GUTTER.
NO WATER VALVE BOXES, METERS, PORTIONS OF MANHOLES, OR OTHER APPURTENANCES OF ANY KIND RELATING TO ANY UNDERGROUND UTILITIES SHALL BE LOCATED IN ANY PORTION OF A CURB AND GUTTER SECTION.
THE CURB AND GUTTER FLOW LINE GRADES SHALL RUN PARALLEL TO THE ROAD CENTERLINE GRADE. THE MINIMUM ALLOWABLE FLOW LINE GRADE OF CURBS AND GUTTERS SHALL BE 0.30%, EXCEPT IN INTERSECTIONS WHERE FLATTER GRADES SHALL BE ALLOWABLE.
JOINTS SHALL BE SAVED (UNLESS AN ALTERNATE METHOD IS USED) AT INTERVALS OF TEN (10) FEET, EXCEPT WHERE SHORTER INTERVALS ARE REQUIRED FOR CLOSURES, BUT, IN NO CASE, LESS THAN FOUR (4) FEET. JOINTS SHALL BE CUT ON THE SAME DAY THAT THE CURB AND GUTTER IS POURED.
ALL CROSS-STREET VALLEY GUTTERS SHALL BE CONSTRUCTED OF CONCRETE.
- DECORATIVE PAVEMENT**
THE USE OF DECORATIVE PAVEMENT SHALL BE SUBJECT TO THE APPROVAL OF THE COUNTY MANAGER OR DESIGNEE. THE COUNTY SHALL NOT ASSUME THE MAINTENANCE OF DECORATIVE PAVEMENT SECTIONS. MAINTENANCE SHALL BE THE RESPONSIBILITY OF A HOMEOWNERS ASSOCIATION OR OTHER ACCEPTABLE ENTITY.
THE COUNTY SHALL HAVE THE RIGHT TO MODIFY, ALTER, OR REMOVE ALL OR A PORTION OF THE DECORATIVE PAVEMENT AS NECESSARY FOR ROADWAY IMPROVEMENTS OR IMPROVEMENTS FOR TRAFFIC SAFETY.
BOMANITE PAVEMENT - BOMANITE PAVEMENTS SHALL MEET THE REQUIREMENTS FOR CONCRETE PAVEMENT IN THE FLORIDA DEPARTMENT OF TRANSPORTATION STANDARD SPECIFICATIONS FOR ROAD AND BRIDGE CONSTRUCTION. THE DEVELOPER SHALL SUBMIT TO THE COUNTY, FOR APPROVAL, MANUFACTURER SPECIFICATIONS CONFIRMING ADHERENCE TO THESE REGULATIONS.
PAVING BRICKS - THE USE OF PAVING BRICKS SHALL BE SUBJECT TO THE APPROVAL OF THE COUNTY. THE DEVELOPER SHALL SUBMIT TO THE COUNTY, FOR APPROVAL, MANUFACTURER'S LITERATURE AND TECHNICAL SPECIFICATIONS REGARDING THE STRUCTURAL STRENGTH, SKID RESISTANCE AND SUBGRADE REQUIREMENTS.
- TESTING**
TESTING SHALL BE PROVIDED AS PART OF CONSTRUCTION AND SHALL BE AT NO COST TO THE COUNTY. TESTING SHALL BE PERFORMED BY AN INDEPENDENT ENGINEERING TESTING LABORATORY CERTIFIED IN THE STATE OF FLORIDA.
THE FOLLOWING ARE MINIMUM TESTING REQUIREMENTS:
SUBGRADE - TESTING FOR THE SUBGRADE THICKNESS, BEARING VALUE AND DENSITY SHALL BE LOCATED NO MORE THAN FIVE HUNDRED (500) FEET APART AND SHALL BE STAGGERED TO THE LEFT, RIGHT AND ON THE CENTERLINE OF THE ROADWAY. THE COUNTY MAY ALSO REQUIRE ADDITIONAL TEST LOCATIONS AS DIRECTED BY THE COUNTY MANAGER OR DESIGNEE. THERE SHALL BE NO LESS THAN ONE TEST PER ROAD. TESTING SHALL INCLUDE: TEST CORES TAKEN AFTER SEVEN DAYS TO VERIFY THICKNESS AND TESTING TO VERIFY A MINIMUM SEVEN DAY COMPRESSIVE STRENGTH OF 300 PSI. TESTING SHALL BE IN ACCORDANCE WITH APPLICABLE FDOT, AASHTO, OR ASTM STANDARDS. CERTIFIED TEST RESULTS SHALL BE SUBMITTED TO THE COUNTY FOR APPROVAL PRIOR TO PROCEEDING WITH THE BASE COURSE.
LIMEROCK BASE - TESTING FOR THE BASE THICKNESS AND DENSITY SHALL BE LOCATED NO MORE THAN 500 FEET APART AND SHALL BE STAGGERED TO THE LEFT, RIGHT AND ON THE CENTERLINE OF THE ROADWAY. THE COUNTY MAY ALSO REQUIRE ADDITIONAL TEST LOCATIONS AS DIRECTED BY THE COUNTY MANAGER OR DESIGNEE. THERE SHALL BE NO LESS THAN ONE TEST PER ROAD. TESTING SHALL INCLUDE: MODIFIED PROCTOR MAXIMUM DENSITY, IN-PLACE FIELD DENSITY AND THICKNESS. TESTING SHALL BE IN ACCORDANCE WITH APPLICABLE FDOT, AASHTO, OR ASTM STANDARDS. CERTIFIED TEST RESULTS SHALL BE SUBMITTED TO THE COUNTY FOR APPROVAL PRIOR TO PROCEEDING WITH THE WEARING SURFACE.
SOIL / CEMENT BASE - TESTING FOR THE BASE THICKNESS AND STRENGTH SHALL BE LOCATED NO MORE THAN 500 FEET APART AND SHALL BE STAGGERED TO THE LEFT, RIGHT AND ON THE CENTERLINE OF THE ROADWAY. THE COUNTY MAY ALSO REQUIRE ADDITIONAL TEST LOCATIONS AS DIRECTED BY THE COUNTY MANAGER OR DESIGNEE. THERE SHALL BE NO LESS THAN ONE TEST PER ROAD. TESTING SHALL INCLUDE: CERTIFIED DESIGN MIX SUBMITTED FOR APPROVAL PRIOR TO PLACING ASPHALT. EXTRACTIONS TAKEN IN FIELD AT LEAST ONE PER DAY AND CORINGS TO VERIFY THICKNESS. TESTING SHALL BE IN ACCORDANCE WITH APPLICABLE FDOT, AASHTO, OR ASTM STANDARDS. CERTIFIED TEST RESULTS SHALL BE SUBMITTED TO THE COUNTY FOR APPROVAL.
WEARING SURFACE - TESTING FOR WEARING SURFACE THICKNESS SHALL BE LOCATED NO MORE THAN 500 FEET APART AND SHALL BE STAGGERED TO THE LEFT, RIGHT AND ON THE CENTERLINE OF THE ROADWAY. THE COUNTY MAY ALSO REQUIRE ADDITIONAL TEST LOCATIONS AS DIRECTED BY THE COUNTY MANAGER OR DESIGNEE. THERE SHALL BE NO LESS THAN ONE TEST PER ROAD. TESTING SHALL INCLUDE: CERTIFIED DESIGN MIX SUBMITTED FOR APPROVAL PRIOR TO PLACING ASPHALT. EXTRACTIONS TAKEN IN FIELD AT LEAST ONE PER DAY AND CORINGS TO VERIFY THICKNESS. TESTING SHALL BE IN ACCORDANCE WITH APPLICABLE FDOT, AASHTO, OR ASTM STANDARDS. CERTIFIED TEST RESULTS SHALL BE SUBMITTED TO THE COUNTY FOR APPROVAL.
- ALL CONCRETE DRIVEWAYS TO BE 6", FIBER REINFORCED, 3,000 PSI.**

HEIDT DESIGN
Civil Engineering • Planning & GIS
Transportation Engineering
Ecological Services • Landscape Architecture
Engineering Business Certificate of Authorization No. 28787D
Landscape Architecture Certificate of Authorization No. LC26060405
www.HeidtDesign.com

**VILLAGE 4
SAWGRASS BLVD. LEFT TURN LANE
TYPICAL SECTION**

PREPARED FOR: **KMF ALTON**

DATE	DESCRIPTION

DATE	DESCRIPTION
07/15/2022	REVISED PER COUNTY COMMENTS
05/27/2022	REVISED PER COUNTY COMMENTS
06/04/2022	REVISED SUBMITTAL

PROJECT NO.: **KMF-SN-1007**

FILE: **RS**
DESIGN BY: **J. VIDALES**
DRAWN BY: **J. VIDALES**

STATE OF FLORIDA
PROFESSIONAL ENGINEER
Michael R. Tucker, State of Florida
Professional Engineer, License
No. 40569

This item has been digitally signed and sealed by Michael R. Tucker, P.E. on the date indicated here.



Printed copies of this document are not considered signed and sealed and the signature must be verified on any electronic copies.

MICHAEL R. TUCKER
DATE: **4/15/2022**
LICENSE NO. **40569**

C-200



ELEVATIONS BASED ON:
NORTH AMERICAN VERTICAL DATUM 1988
CONVERSION:
NAVD 88 TO NGVD 29 = +0.86

RAVALON GROVES/SAWGRASS BLVD VILLAGE 4 ENTRANCE/ENGINEERING DWG-C-200/02/2022/11:57 AM/BRETT DAVIS

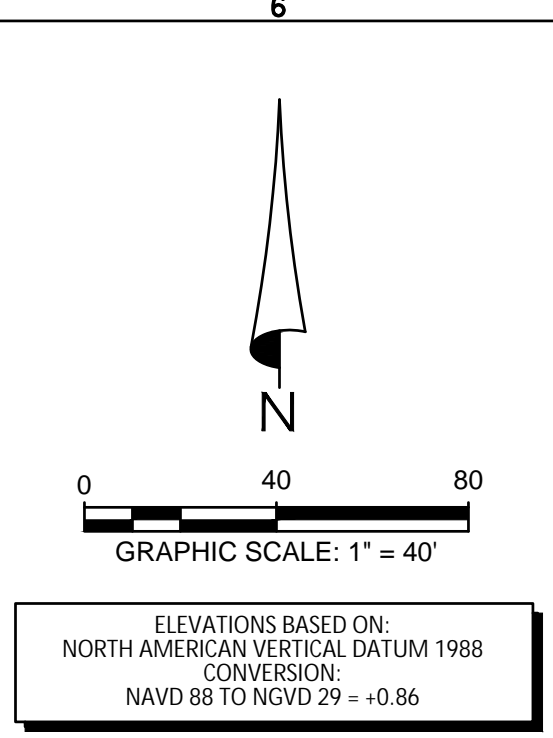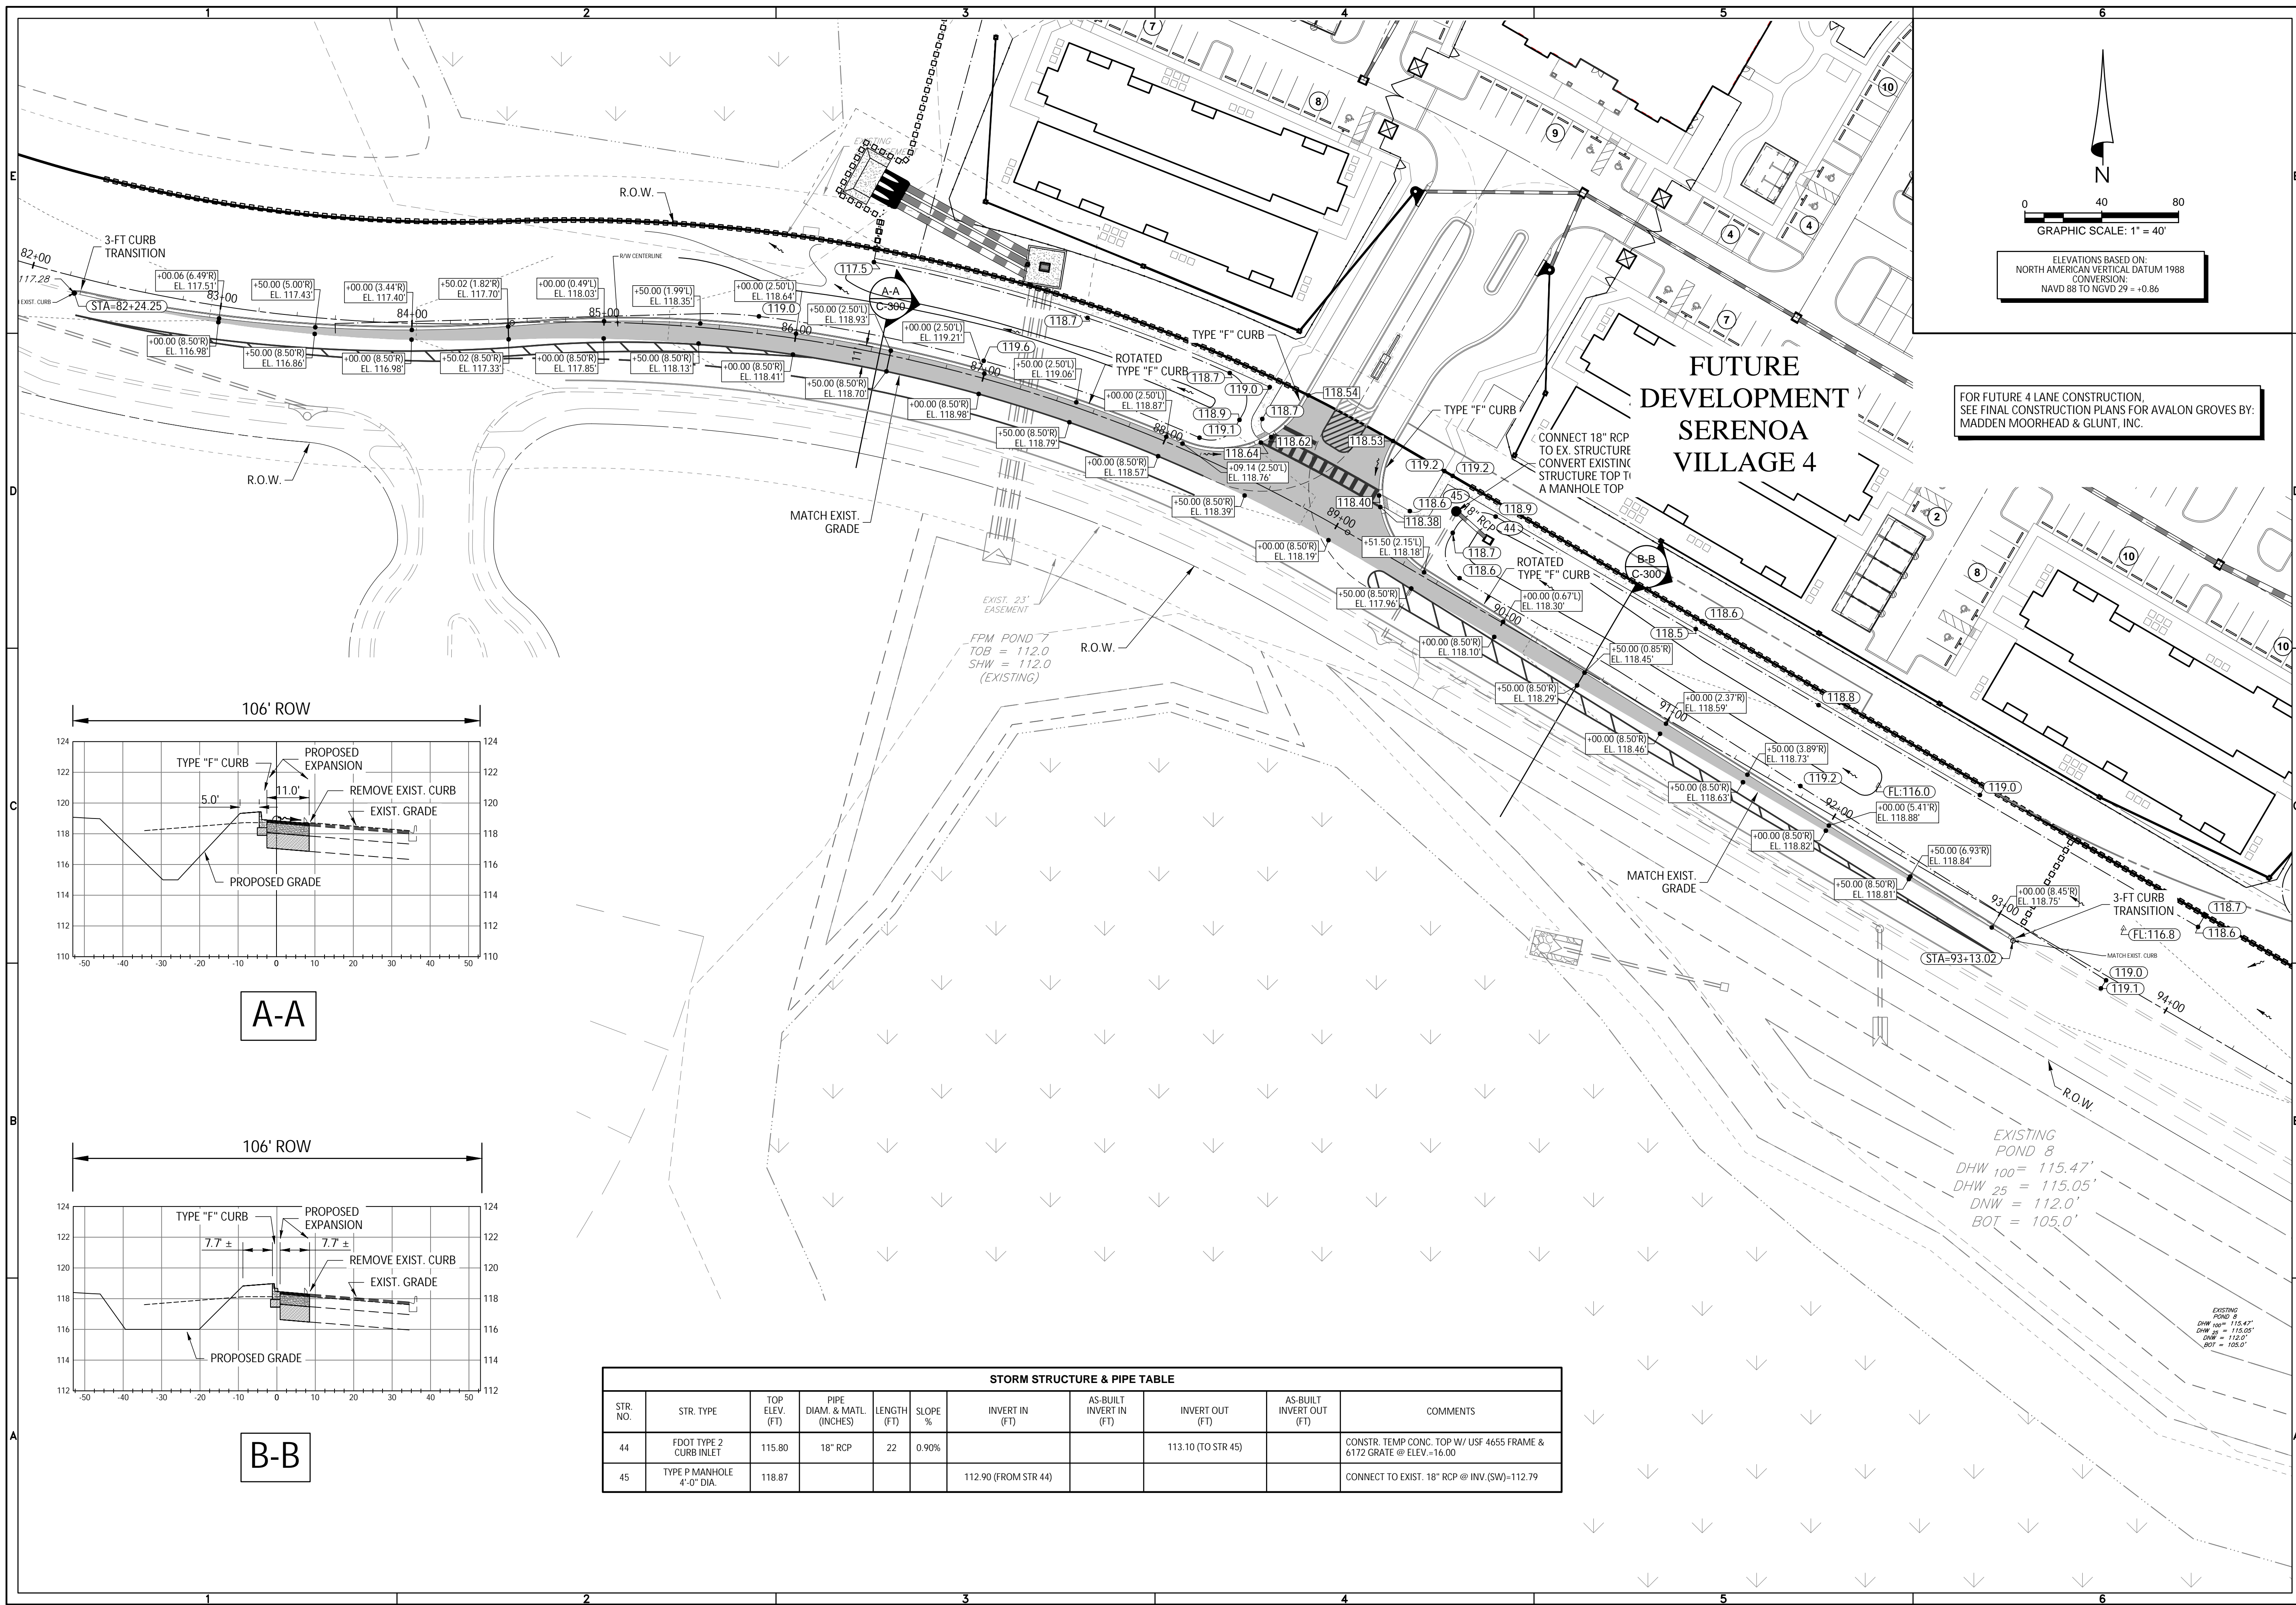

FOR FUTURE 4 LANE CONSTRUCTION, SEE FINAL CONSTRUCTION PLANS FOR AVALON GROVES BY: MADDEN MOORHEAD & GLUNT, INC.

FUTURE DEVELOPMENT SERENOA VILLAGE 4

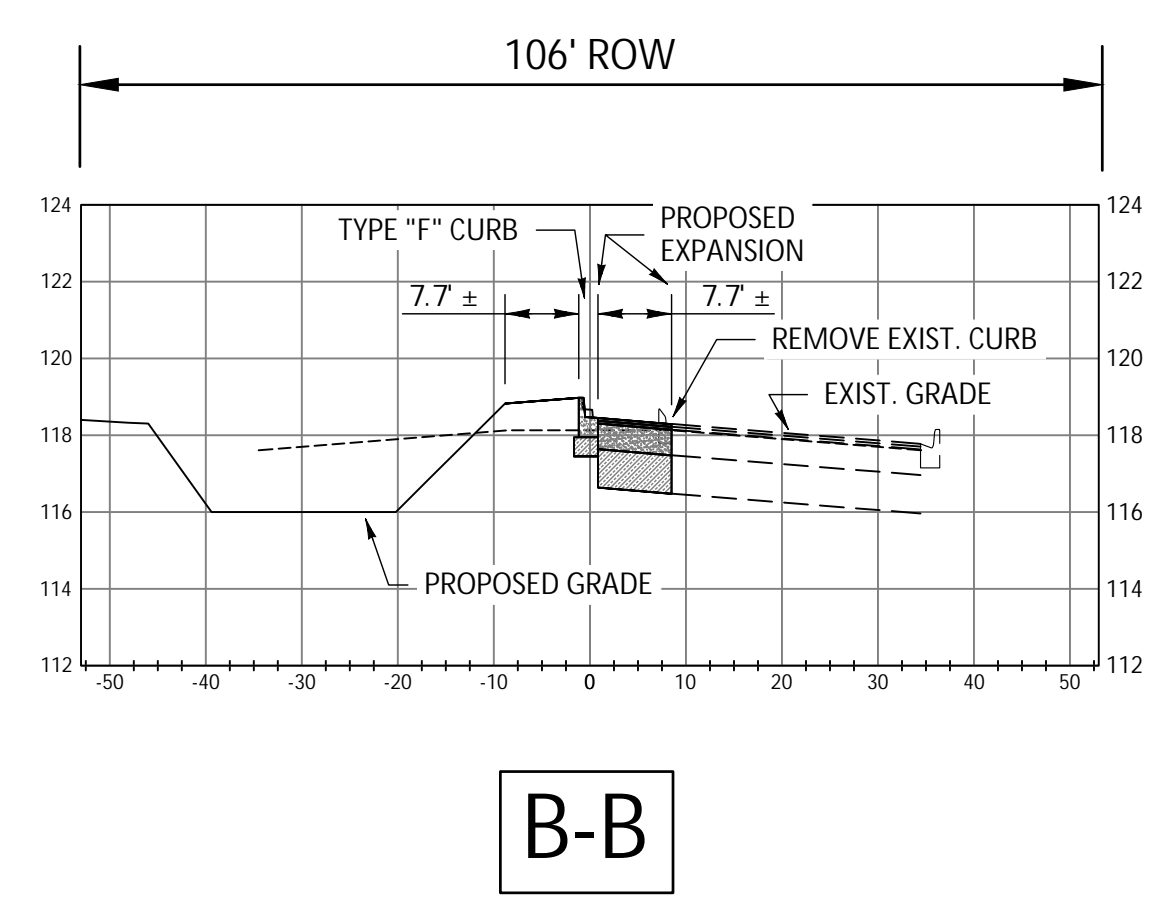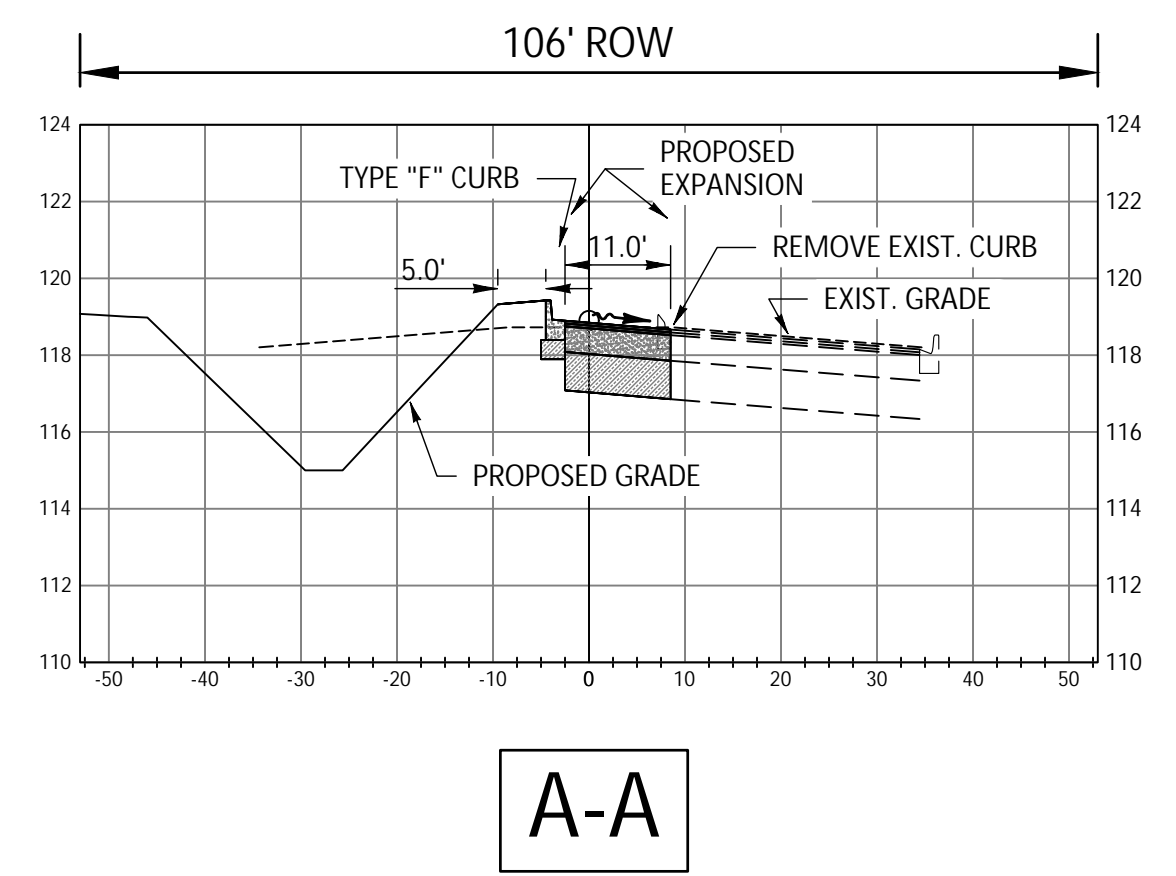

STORM STRUCTURE & PIPE TABLE										
STR. NO.	STR. TYPE	TOP ELEV. (FT)	PIPE DIAM. & MATL. (INCHES)	LENGTH (FT)	SLOPE %	INVERT IN (FT)	AS-BUILT INVERT IN (FT)	INVERT OUT (FT)	AS-BUILT INVERT OUT (FT)	COMMENTS
44	FDOT TYPE 2 CURB INLET	115.80	18" RCP	22	0.90%			113.10 (TO STR 45)		CONSTR. TEMP CONC. TOP W/ USF 4655 FRAME & 6172 GRATE @ ELEV.=16.00
45	TYPE P MANHOLE 4'-0" DIA.	118.87				112.90 (FROM STR 44)				CONNECT TO EXIST. 18" RCP @ INV.(SW)=112.79

EXISTING POND 8
 DHW 100' = 115.47'
 DHW 25' = 115.05'
 DNW = 112.0'
 BOT = 105.0'

HEIDT DESIGN
 Civil Engineering • Planning & GIS
 Transportation Engineering
 Ecological Services • Landscape Architecture

5904-A Hampton Oaks Pkwy.
 Tampa, Florida 33610
 Office: 813-253-5311
 Fax: 813-464-7629
 www.HeidtDesign.com

Engineering Business Certificate of Authorization No. 28793
 Landscape Architecture Certificate of Authorization No. LC26080405

VILLAGE 4
 SAWGRASS BLVD. LEFT TURN LANE
 GRADING PLAN & ROAD SECTIONS

PREPARED FOR: **KMF ALTON**

NO.	DATE	DESCRIPTION
2	07/15/2022	REVISED PER COUNTY COMMENTS
1	05/27/2022	REVISED PER COUNTY COMMENTS
	08/04/2022	REVISED SUBMITTAL

PROJECT NO.: KMF-SN-1007
 FILE: GD
 DESIGN BY: J. VIDALES
 DRAWN BY: J. VIDALES

STATE OF FLORIDA
 PROFESSIONAL ENGINEER

Michael R. Tucker, State of Florida
 Professional Engineer, License
 No. 40569


This item has been digitally
 signed and sealed by
 Michael R. Tucker, P.E. on the
 date indicated here.

Printed copies of this document
 are not considered signed and
 sealed and the signature must be
 verified on any electronic copies.

MICHAEL R. TUCKER
 DATE: _____
 LICENSE NO. 40569

C-300

RAVALON GROVES/SAWGRASS BLVD VILLAGE 4 ENTRANCE/ENGINEERING DWG-C-300 2022/07/15 11:57 AM BRETT DAVIS

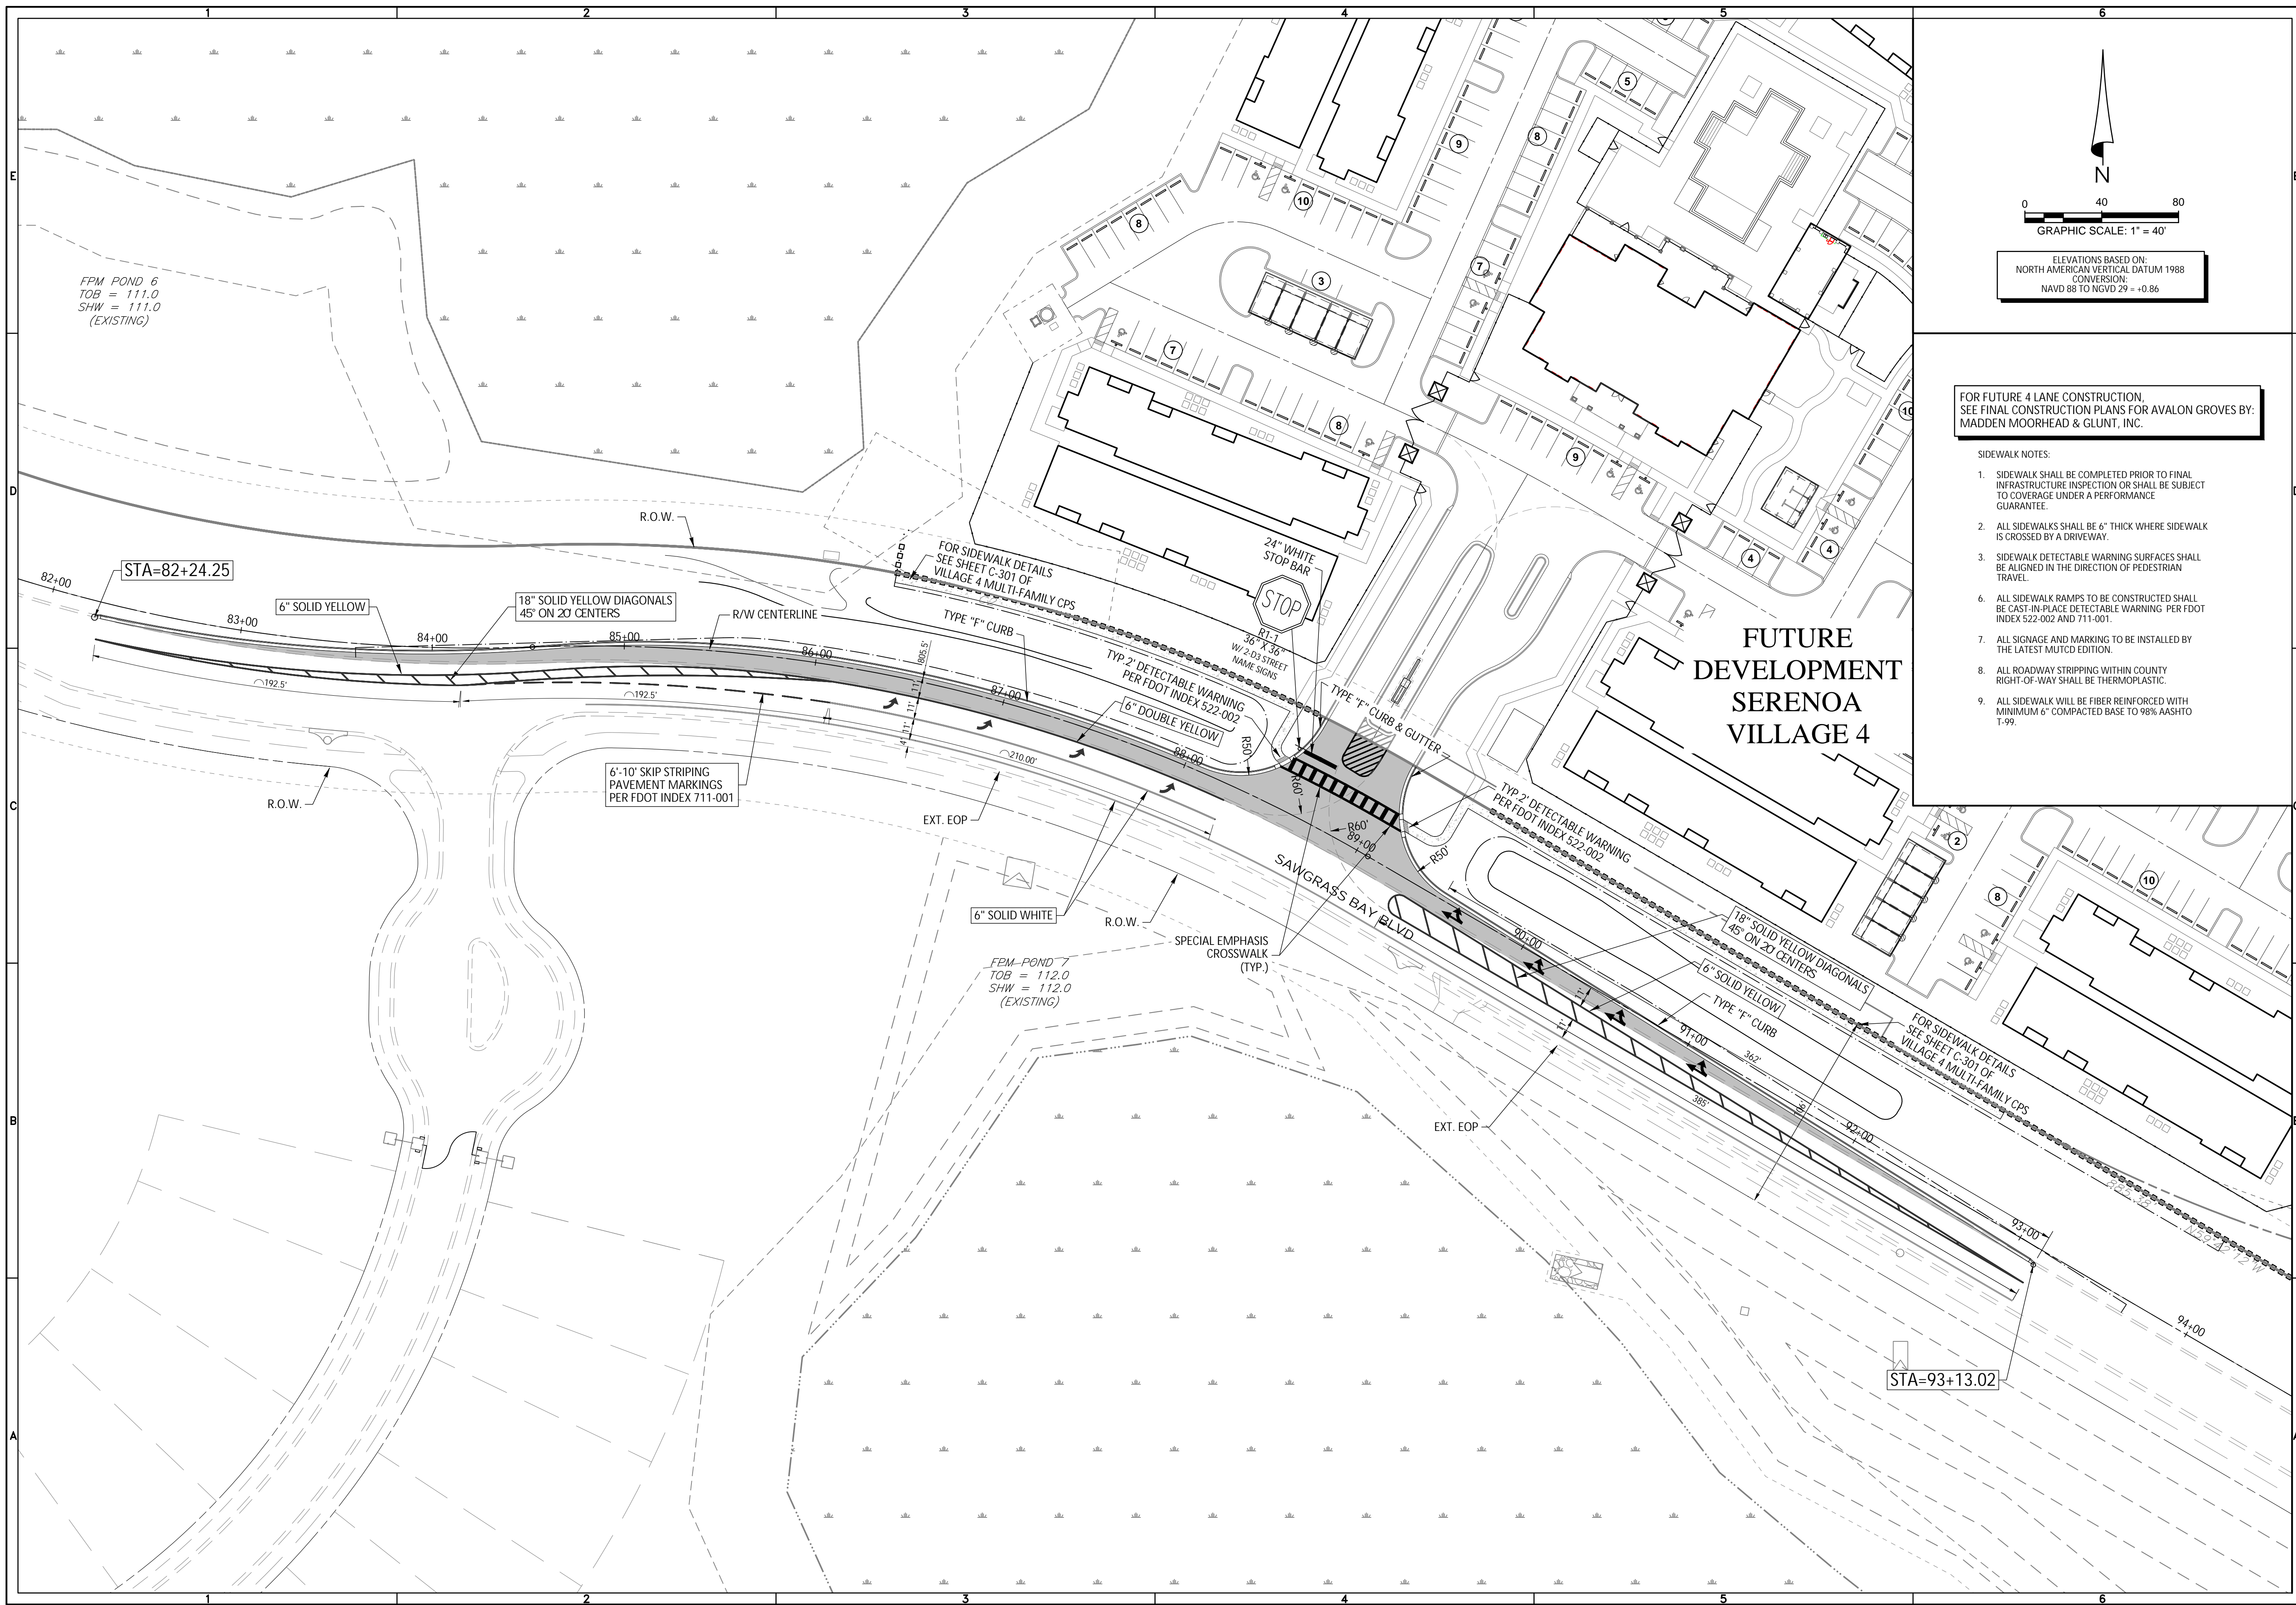

N

0 40 80

GRAPHIC SCALE: 1" = 40'

ELEVATIONS BASED ON:
NORTH AMERICAN VERTICAL DATUM 1988
CONVERSION:
NAVD 88 TO NGVD 29 = +0.86

FOR FUTURE 4 LANE CONSTRUCTION,
SEE FINAL CONSTRUCTION PLANS FOR AVALON GROVES BY:
MADDEN MOORHEAD & GLUNT, INC.

- SIDEWALK NOTES:**
1. SIDEWALK SHALL BE COMPLETED PRIOR TO FINAL INFRASTRUCTURE INSPECTION OR SHALL BE SUBJECT TO COVERAGE UNDER A PERFORMANCE GUARANTEE.
 2. ALL SIDEWALKS SHALL BE 6" THICK WHERE SIDEWALK IS CROSSED BY A DRIVEWAY.
 3. SIDEWALK DETECTABLE WARNING SURFACES SHALL BE ALIGNED IN THE DIRECTION OF PEDESTRIAN TRAVEL.
 4. ALL SIDEWALK RAMP TO BE CONSTRUCTED SHALL BE CAST-IN-PLACE DETECTABLE WARNING PER FDOT INDEX 522-002 AND 711-001.
 5. ALL SIGNAGE AND MARKING TO BE INSTALLED BY THE LATEST MUTCD EDITION.
 6. ALL ROADWAY STRIPPING WITHIN COUNTY RIGHT-OF-WAY SHALL BE THERMOPLASTIC.
 7. ALL SIDEWALK WILL BE FIBER REINFORCED WITH MINIMUM 6" COMPACTED BASE TO 98% AASHTO T-99.

HEIDT DESIGN
Civil Engineering • Planning & GIS
Transportation Engineering
Ecological Services • Landscape Architecture

5904-A Hampton Oaks Pkwy.
Tampa, Florida 33610
Office: 813-253-5311
Fax: 813-464-7629
www.HeidtDesign.com

Engineering Business Certificate of Authorization No. 28783
Landscape Architecture Certificate of Authorization No. LC26080405

**VILLAGE 4
SAWGRASS BLVD. LEFT TURN LANE
SIGNING & PAVEMENT MARKINGS
PLAN**

PREPARED FOR: **KMF ALTON**

DATE	DESCRIPTION

DATE	DESCRIPTION
07/15/2022	REVISED PER COUNTY COMMENTS
05/27/2022	REVISED PER COUNTY COMMENTS
06/04/2022	REVISED SUBMITTAL

PROJECT NO.: **KMF-SN-1007**
FILE: **SPM**
DESIGN BY: **J. VIDALES**
DRAWN BY: **J. VIDALES**

**STATE OF FLORIDA
PROFESSIONAL ENGINEER**

Michael R. Tucker, State of Florida
Professional Engineer, License
No. 40569

This item has been digitally
signed and sealed by
Michael R. Tucker, P.E. on the
date indicated here.

Printed copies of this document
are not considered signed and
sealed and the signature must be
verified on any electronic copies.

MICHAEL R. TUCKER
DATE: _____
LICENSE NO. **40569**

C-700

R:\AVALON GROVES\SAWGRASS BLVD VILLAGE 4 ENTRANCE\ENGINEERING\SPM\DWG-C-700 2022\0715 11.57 AM BRETT DAVIS